



PART PLAN - 41ST FLOOR

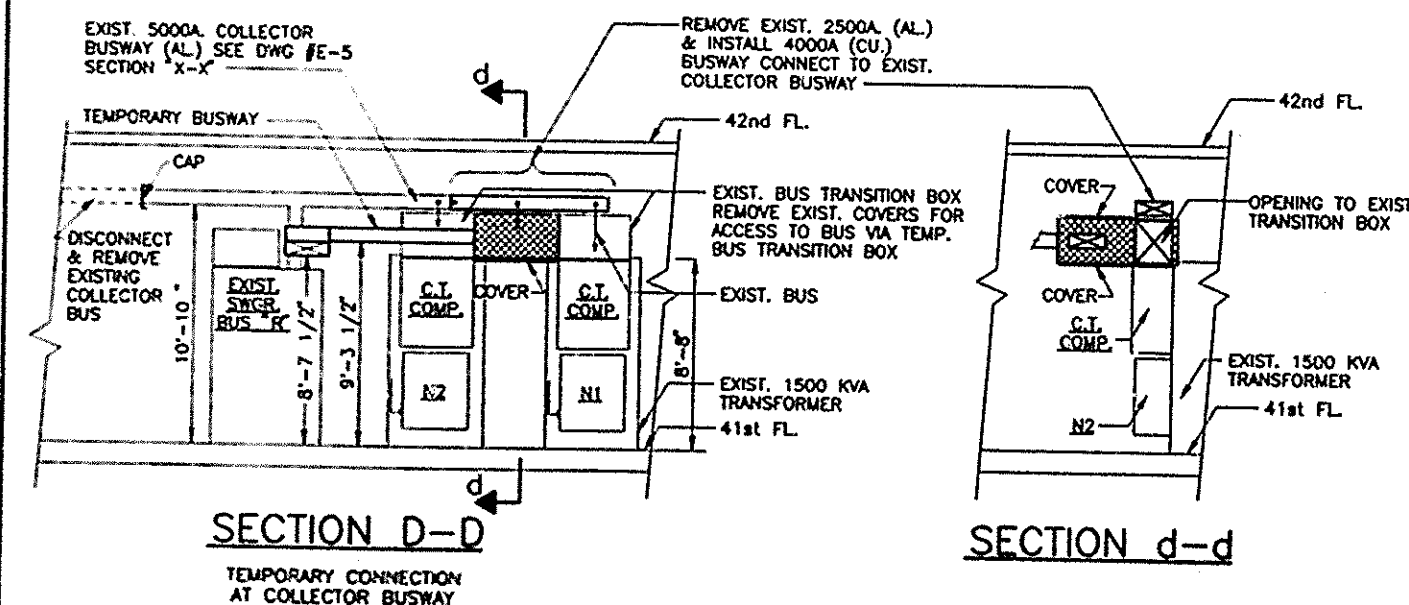

SECTION D-D


SECTION d-d

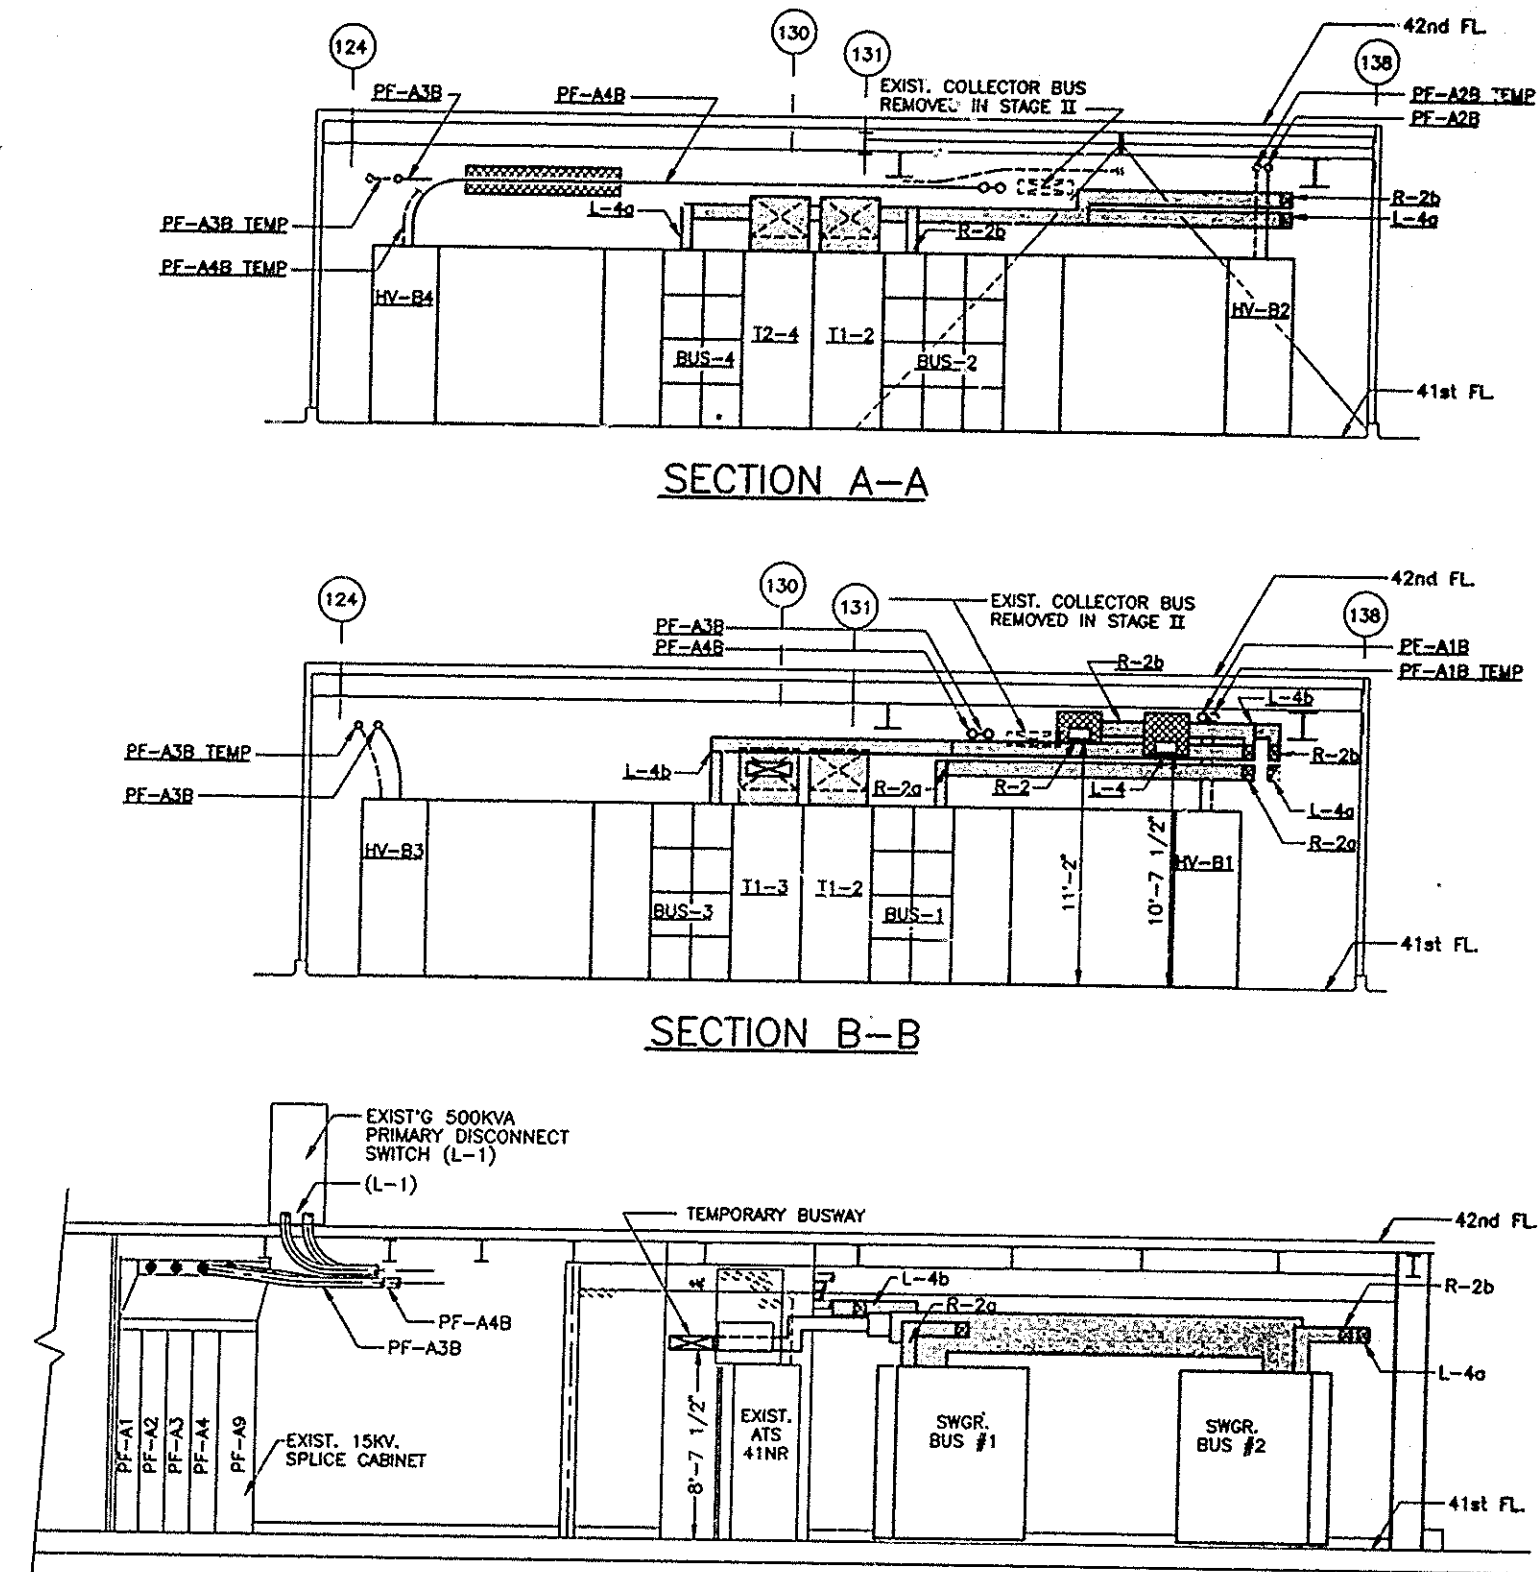

SECTION A-A

SECTION B-B

SECTION C-C

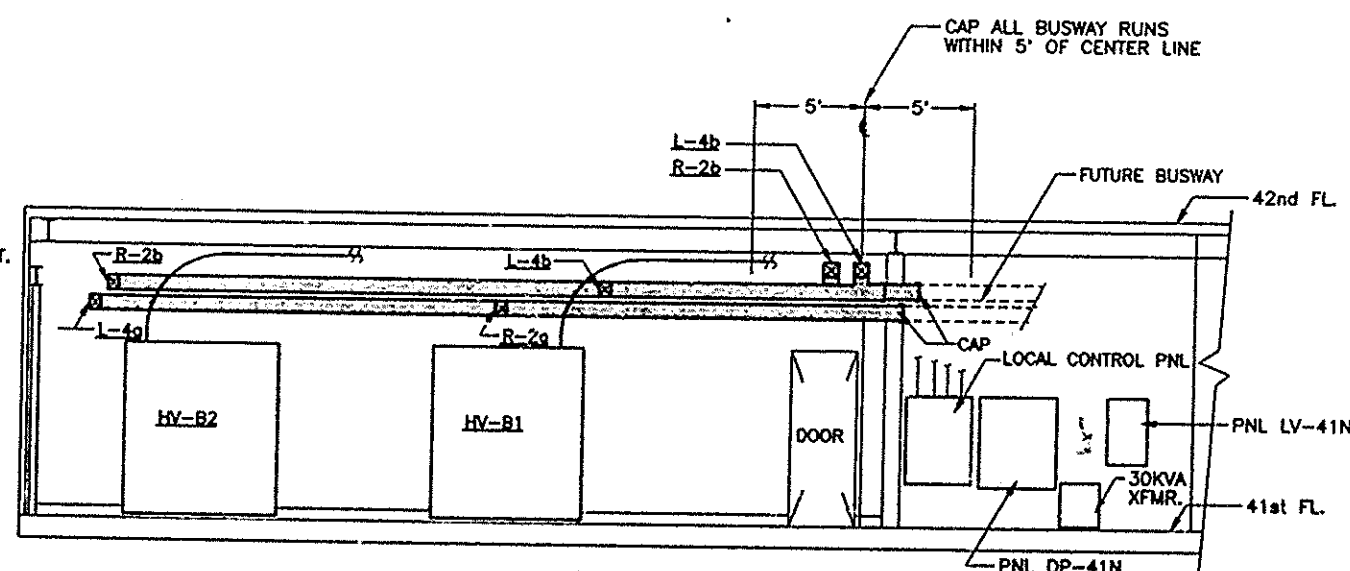

SECTION E-E

I HEREBY CERTIFY THAT THIS IS A TRUE AND CORRECT COPY OF ONE OF THE CONTRACT DRAWINGS CONSTITUTING A PART OF CONTRACT NO. WTC-802.071 IN THE FORM IN WHICH SAID DRAWINGS EXISTED AT THE TIME THE SAID CONTRACT WAS EXECUTED BY THE PARTIES.

DATE 6/21/95 Sultan A. Aslam
SPEC. WRITER
DATE 8/15/95 Peter H. Dweeney
ENGINEER OF DESIGN

NOTE:

1. THIS DRAWING SHOWS BOTH STAGE II AND III WORK COMBINED. FOR SEPARATION OF WORK SEE NOTE #3 DWG. #E-11.
2. FOR WORK IN ELECTRIC CLOSET "C" SEE DRAWING E-12, ONE LINE DIAGRAM
3. FOR LOCAL CONTROL PANEL DETAILS SEE DRAWING E-107
4. FOR BUSWAY REQUIREMENTS SEE DWG. #E-2 GENERAL NOTE #17.

0 4 8 12 16

SCALE IN FEET



**THE PORT AUTHORITY
OF NY & NJ**

Peter K. Swenney
ENGINEERING PROGRAM MANAGER
WORLD TRADE CENTER

[Signature]
CHIEF ELECTRICAL ENGINEER

Engineering Department					
Design Divisions					

The World Trade Center Electrical/HVAC Upgrade Program

Title
TOWER ONE AND TWO
LOW VOLTAGE
SUBSTATIONS
CONSTRUCTION AND
INSTALLATION

ELECTRICAL

SUBSTATION SS-41N
STAGE II AND III
SWITCHGEAR EQUIPMENT
PLAN & SECTIONS

No.	Date	Revision	Approved
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This drawing subject to conditions in contract.
All inventions, ideas, designs and methods
herein are reserved to Port Authority and
may not be used without its written consent.

LEAHY/ FISCHER	LEAHY	A.S.
Designed by	Drawn by	Checked by

Date 5-1-93 Scale AS NOTED

Contract Number: Drawing Number:

WTC 802.071 F-14